NOTES

- 1. ALL LINES ARE TO BE MIN. 100Ø UPVC @ MIN 1.0% GRADE UNLESS NOTED OTHERWISE.
- 2. IT IS THE CONTRACTORS RESPONSIBILITY TO LOCATE & LEVEL ALL EXISTING SERVICES PRIOR TO THE COMMENCEMENT OF ANY EARTHWORKS. ALL DESIGN LEVELS SHOWN ON PLAN SHALL BE VERIFIED ON SITE PRIOR TO THE COMMENCEMENT OF ANY WORK.
- 3. ALL PIPES TO HAVE MIN 200mm COVER IF LOCATED WITHIN PROPERTY.
- ALL PITS IN DRIVEWAYS BE HEAVY DUTY GRATES. DIRECT 4. SURFACE FLOW TO ALL GRATED SURFACE INLET PITS.
- 5. ALL WORK DO BE DONE IN ACCORDANCE WITH AS/NZ 3500.3.2:1998 AND COUNCIL SPECIFICATIONS.
- 6. LOCATION OF DOWNPIPES & FLOOR WASTES ARE INDICATIVE ONLY. DOWNPIPE & FLOOR WASTE SIZE, LOCATION & QUANTITY TO BE DETERMINED BY BUILDER & IN ACCORDANCE WITH RELEVANT AUSTRALIAN STANDARDS.
- 7. THIS PLAN IS TO BE READ IN CONJUNCTION WITH THE ARCHITECTURAL, LANDSCAPE AND STRUCTURAL PLANS.
- 8. ANY DISCREPANCIES OR OMISSIONS SHALL BE REFERRED TO THE DESIGN ENGINEER FOR RESOLUTION.
- ALL PITS OR GRATES IN TRAFFICABLE AREAS TO BE HEAVY 9. DUTY.
- 10. ALL GUTTERS WILL BE FITTED WITH LEAF GUARDS AND SHOULD BE INSPECTED AND CLEANED TO ENSURE LEAF LITTER CANNOT ENTER THE DOWNPIPES
- 11. EXISTING STORMWATER DRAINAGE TO BE UTILISED WHERE CONTRACTOR SEE FIT.


LEGEND

RL	PIT SURFACE LEVEL
IL	INVERT LEVEL
TK	TOP OF KERB
SW SW	STORMWATER DRAINAGE PIPE
RWT RWT	DOWNPIPE TO RAIN WATER TANK
AGAG	Ø100 SUBSOIL PIPE
OF OF	RAIN WATER TANK OVER FLOW PIPE
RM RM	PROPOSED RISING MAIN
CIS	Ø80mm CAST-IN-SITU
	EXISTING STORMWATER PIPE
O DP	PROPOSED Ø100 DOWN PIPE
• EX-DP	EXISTING DOWN PIPE
• co	CLEAN OUT
DPS	DOWN PIPE SPREADERS
VD	VERTICAL DROP
• VR	VERTICAL RISER
Ø FW	FLOOR WASTE 150Ø
	GRATED INLET PIT
	200mm WIDE GRATED DRAIN



DESIGN NOTES

- GARAGE.

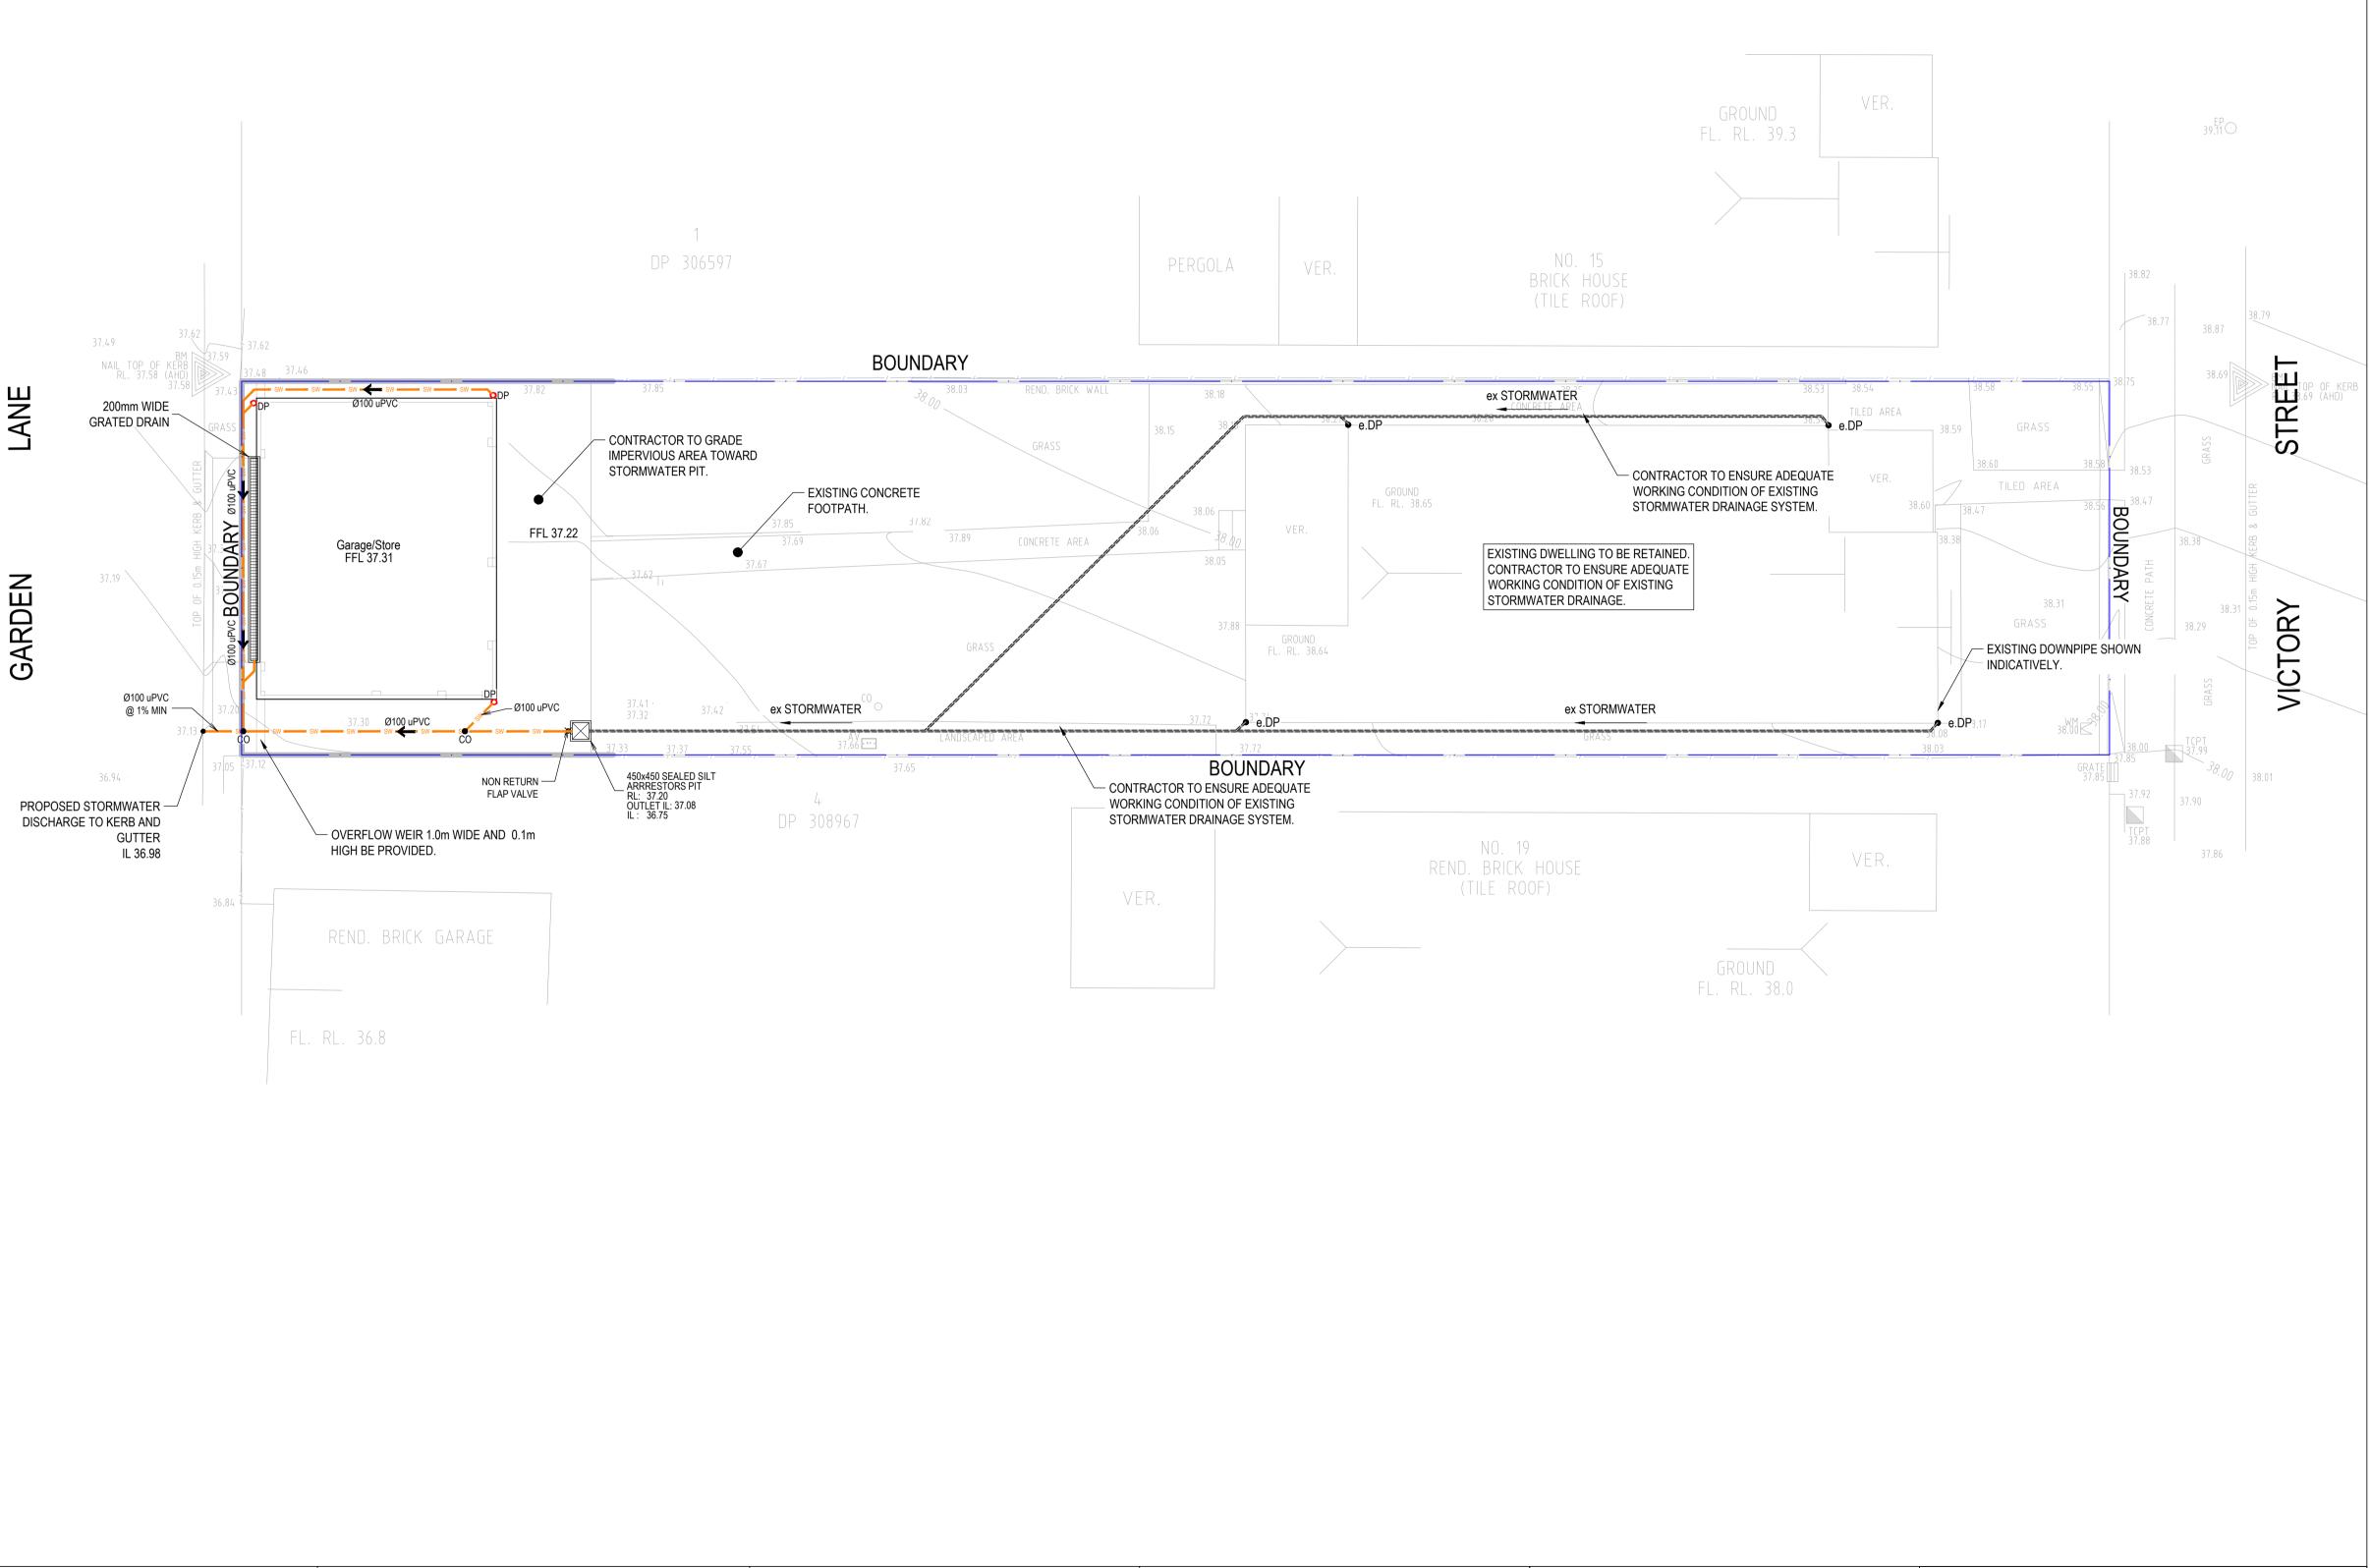


	ISSUED FOR \$4.55 A.E. J.L. 26.11.24	ARCHITECT	SHEET SUBJECT STORMWATER DRAINAGE PLAN	PROJECT: 17 VICTORY STREET, BELMOR DATE DRAWN 15.10.2021 J.L.	DESIGNED CHECKED J.L. A.E.	ISSUED FOR S4.55
	ISSUED FOR C.C. APPROVALA.E.J.L.25.11.22ISSUED FOR C.C. APPROVALA.E.J.L.08.09.22	P: 9037 0731 E: info@aeconsulting.com.au	GROUND FLOOR LEVEL	SCALE @ A1 1:100	JOB № D21289	DO NOT SCALE DRAWING, USE FIGURED DIMENSIONS ONLY
	ISSUED FOR APPROVALA.E.J.L.07.03.22ISSUED FOR APPROVALA.E.J.L.18.20.21			AUTHORISED	DWG No REV	This drawing remains the property of A.E CONSULTING ENGINEERS and must
No	AMENDMENT ENG DRAFT DATE ENGINEE	ERS		A.E.	SW10 E	not be reproduced or used without written consent.
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IN ACCORDANCE WITH COUNCIL GUIDELINES OSD IS NOT REQUIRED FOR SUBJECT DEVELOPMENT.

SCOPE OF WORKS TO INCLUDE CONSTRUCTION OF PROPOSED

LGA = CANTERBURY BANKSTOWN COUNCIL

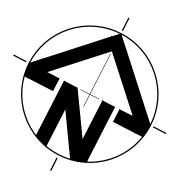

NOTES

- 1. ALL LINES ARE TO BE MIN. 100Ø UPVC @ MIN 1.0% GRADE UNLESS NOTED OTHERWISE.
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LEGEND


RL	PIT SURFACE LEVEL
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	STORMWATER DRAINAGE PIPE
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	EXISTING STORMWATER PIPE
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• EX-DP	EXISTING DOWN PIPE
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DPS	DOWN PIPE SPREADERS
VD	VERTICAL DROP
VR	VERTICAL RISER
Ø FW	FLOOR WASTE 65Ø
	GRATED INLET PIT
	200mm WIDE GRATED DRAIN
🔀 BD	BALCONY DRAIN
Ø PG	PLANTER GRATE
🥝 RWO	ROOF RAINWATER OUTLET




LANE GARDEN




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E ISSUED FOR		A.E. J.L. 26.11.24		P: 9037 0731			MARCO CHRISTOFORIDIS	STORMWATER DRAINAGE PLAN	DATE DRAWN 15.10.2021 J.L.	DESIGNED	CHECKED A.E.	ISSUED FOR S4.55
	R C.C. APPROVAL	A.E. J.L. 25.11.22		P. 9037 0731				ROOF FLOOR LEVEL	SCALE @ A1	JOB No		
	R C.C. APPROVAL	A.E. J.L. 08.09.22		E: info@aeconsulting.com.au					1:100	D21289		DO NOT SCALE DRAWING, USE FIGURED DIMENSIONS ONLY
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A ISSUED FOR	RAPPROVAL	A.E. J.L. 18.20.21		W: www.aeconsulting.com.au					AUTIONISED	Divisitio	IL V	This drawing remains the property of A.E CONSULTING ENGINEERS and must
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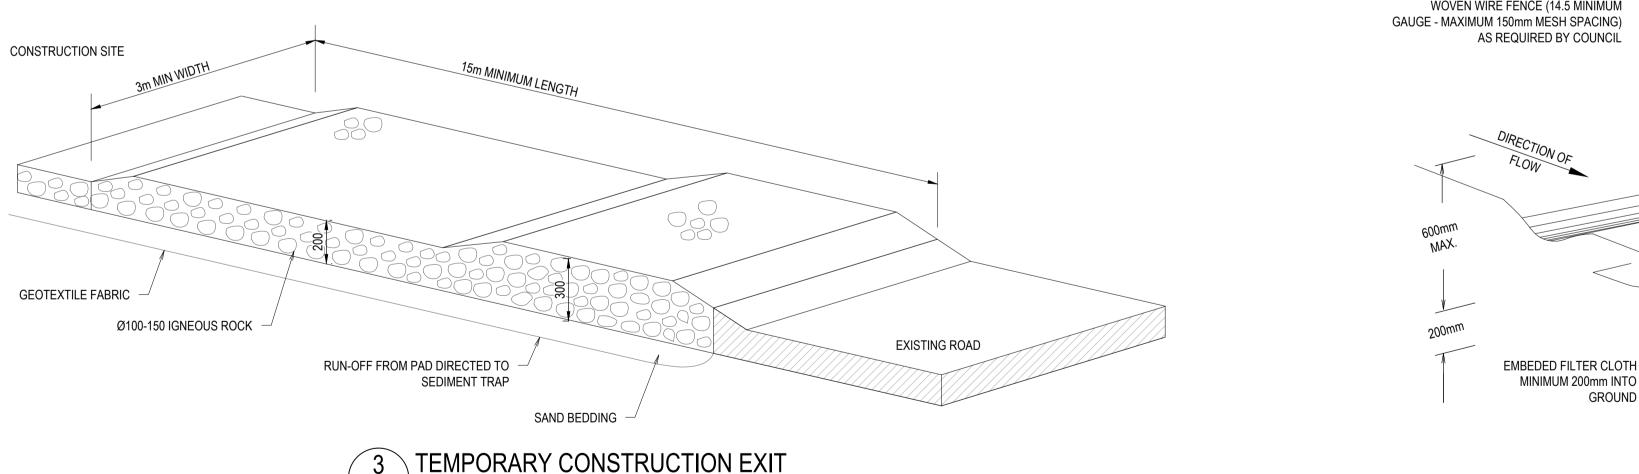


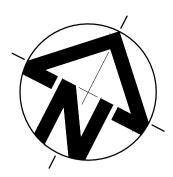


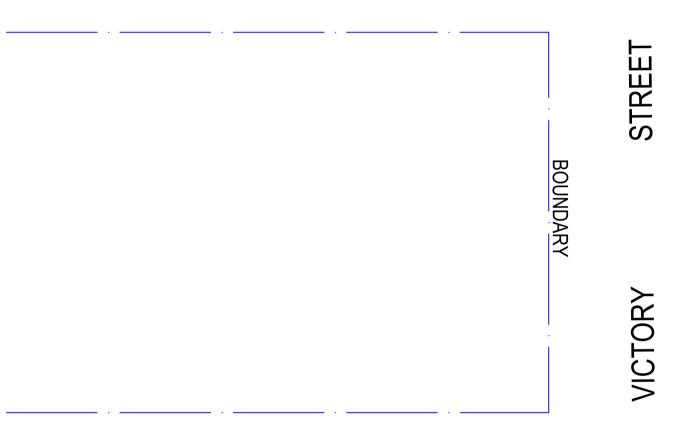EROSION & SEDIMENT CONTROL PLAN SCALE: 1:100 NOTES:

- THIS PLAN IS TO BE READ IN CONJUNCTION 1. WITH THE ENGINEERING PLANS AND ANY OTHER PLANS OR WRITTEN INSTRUCTIONS THAT MAY BE ISSUED AND RELATING TO THE DEVELOPMENT AT THE SUBJECT SITE
- THE CONTRACTOR MUST ENSURE THAT ALL 2. SOIL AND WATER MANAGEMENT WORKS ARE LOCATED AS INSTRUCTED IN THIS SPECIFICATION
- ALL BUILDERS AND SUB-CONTRACTORS SHALL 3. BE INFORMED OF THEIR RESPONSIBILITIES IN MINIMIZING THE POTENTIAL FOR SOIL EROSION AND POLLUTION TO DOWN SLOPE LANDS AND WATERWAYS
- DURING WINDY CONDITIONS, LARGE, 4. UNPROTECTED AREAS SHALL BE KEPT MOIST (NOT WET) BY SPRINKLING WITH WATER TO KEEP DUST UNDER CONTROL
- 5. FINAL SITE LANDSCAPING SHALL BE UNDERTAKEN AS SOON AS POSSIBLE AND WITHIN 20 WORKING DAYS FROM COMPLETION OF CONSTRUCTION ACTIVITIES
- WATER WILL BE PREVENTED FROM ENTERING 6. THE PERMANENT DRAINAGE SYSTEM UNLESS IT IS RELATIVELY SEDIMENT FREE BY FILTERING THROUGH AN APPROVED STRUCTURE
- TEMPORARY SOIL AND WATER MANAGEMENT 7. STRUCTURES SHALL BE REMOVED ONLY AFTER THE LANDS THEY ARE PROTECTING HAVE BEEN REHABILITATED
- EROSION AND SEDIMENT CONTROL MEASURES 8 SHALL BE INSPECTED AFTER RAINFALL EVENTS TO ENSURE THEY HAVE OPERATED EFFECTIVELY AND REMAIN IN WORKING CONDITION
- THE ENTRANCE SHALL BE MAINTAINED IN A 9. CONDITION WHICH PREVENTS TACKING OR FLOWING OF SEDIMENT ONTO PUBLIC RIGHTS OF WAY. THIS MAY REQUIRE PERIODIC TOP DRESSING WITHIN ADDITIONAL GRAVEL AS CONDITIONS DEMAND AND REPAIR AND/OR CLEANOUT OF ANY MEASURES USED TO TRAP SEDIMENT. ALL SEDIMENT SPILLED, DROPPED, WASHED OR TRACKED ONTO PUBLIC RIGHTS OF WAY MUST BE REMOVED IMMEDIATELY
- PROVIDE SILT FENCE/HAY BALE BARRIERS TO 10. THE LOW SIDE OF ALL EXPOSED EARTH EXCAVATIONS (TYPICAL)
- ISOLATE EXISTING STORMWATER PITS WITH 11. HAY BALES TO FILTER ALL INCOMING FLOWS
- DO NOT STOCK PILE EXCAVATED MATERIAL ON 12. THE ROAD WAY




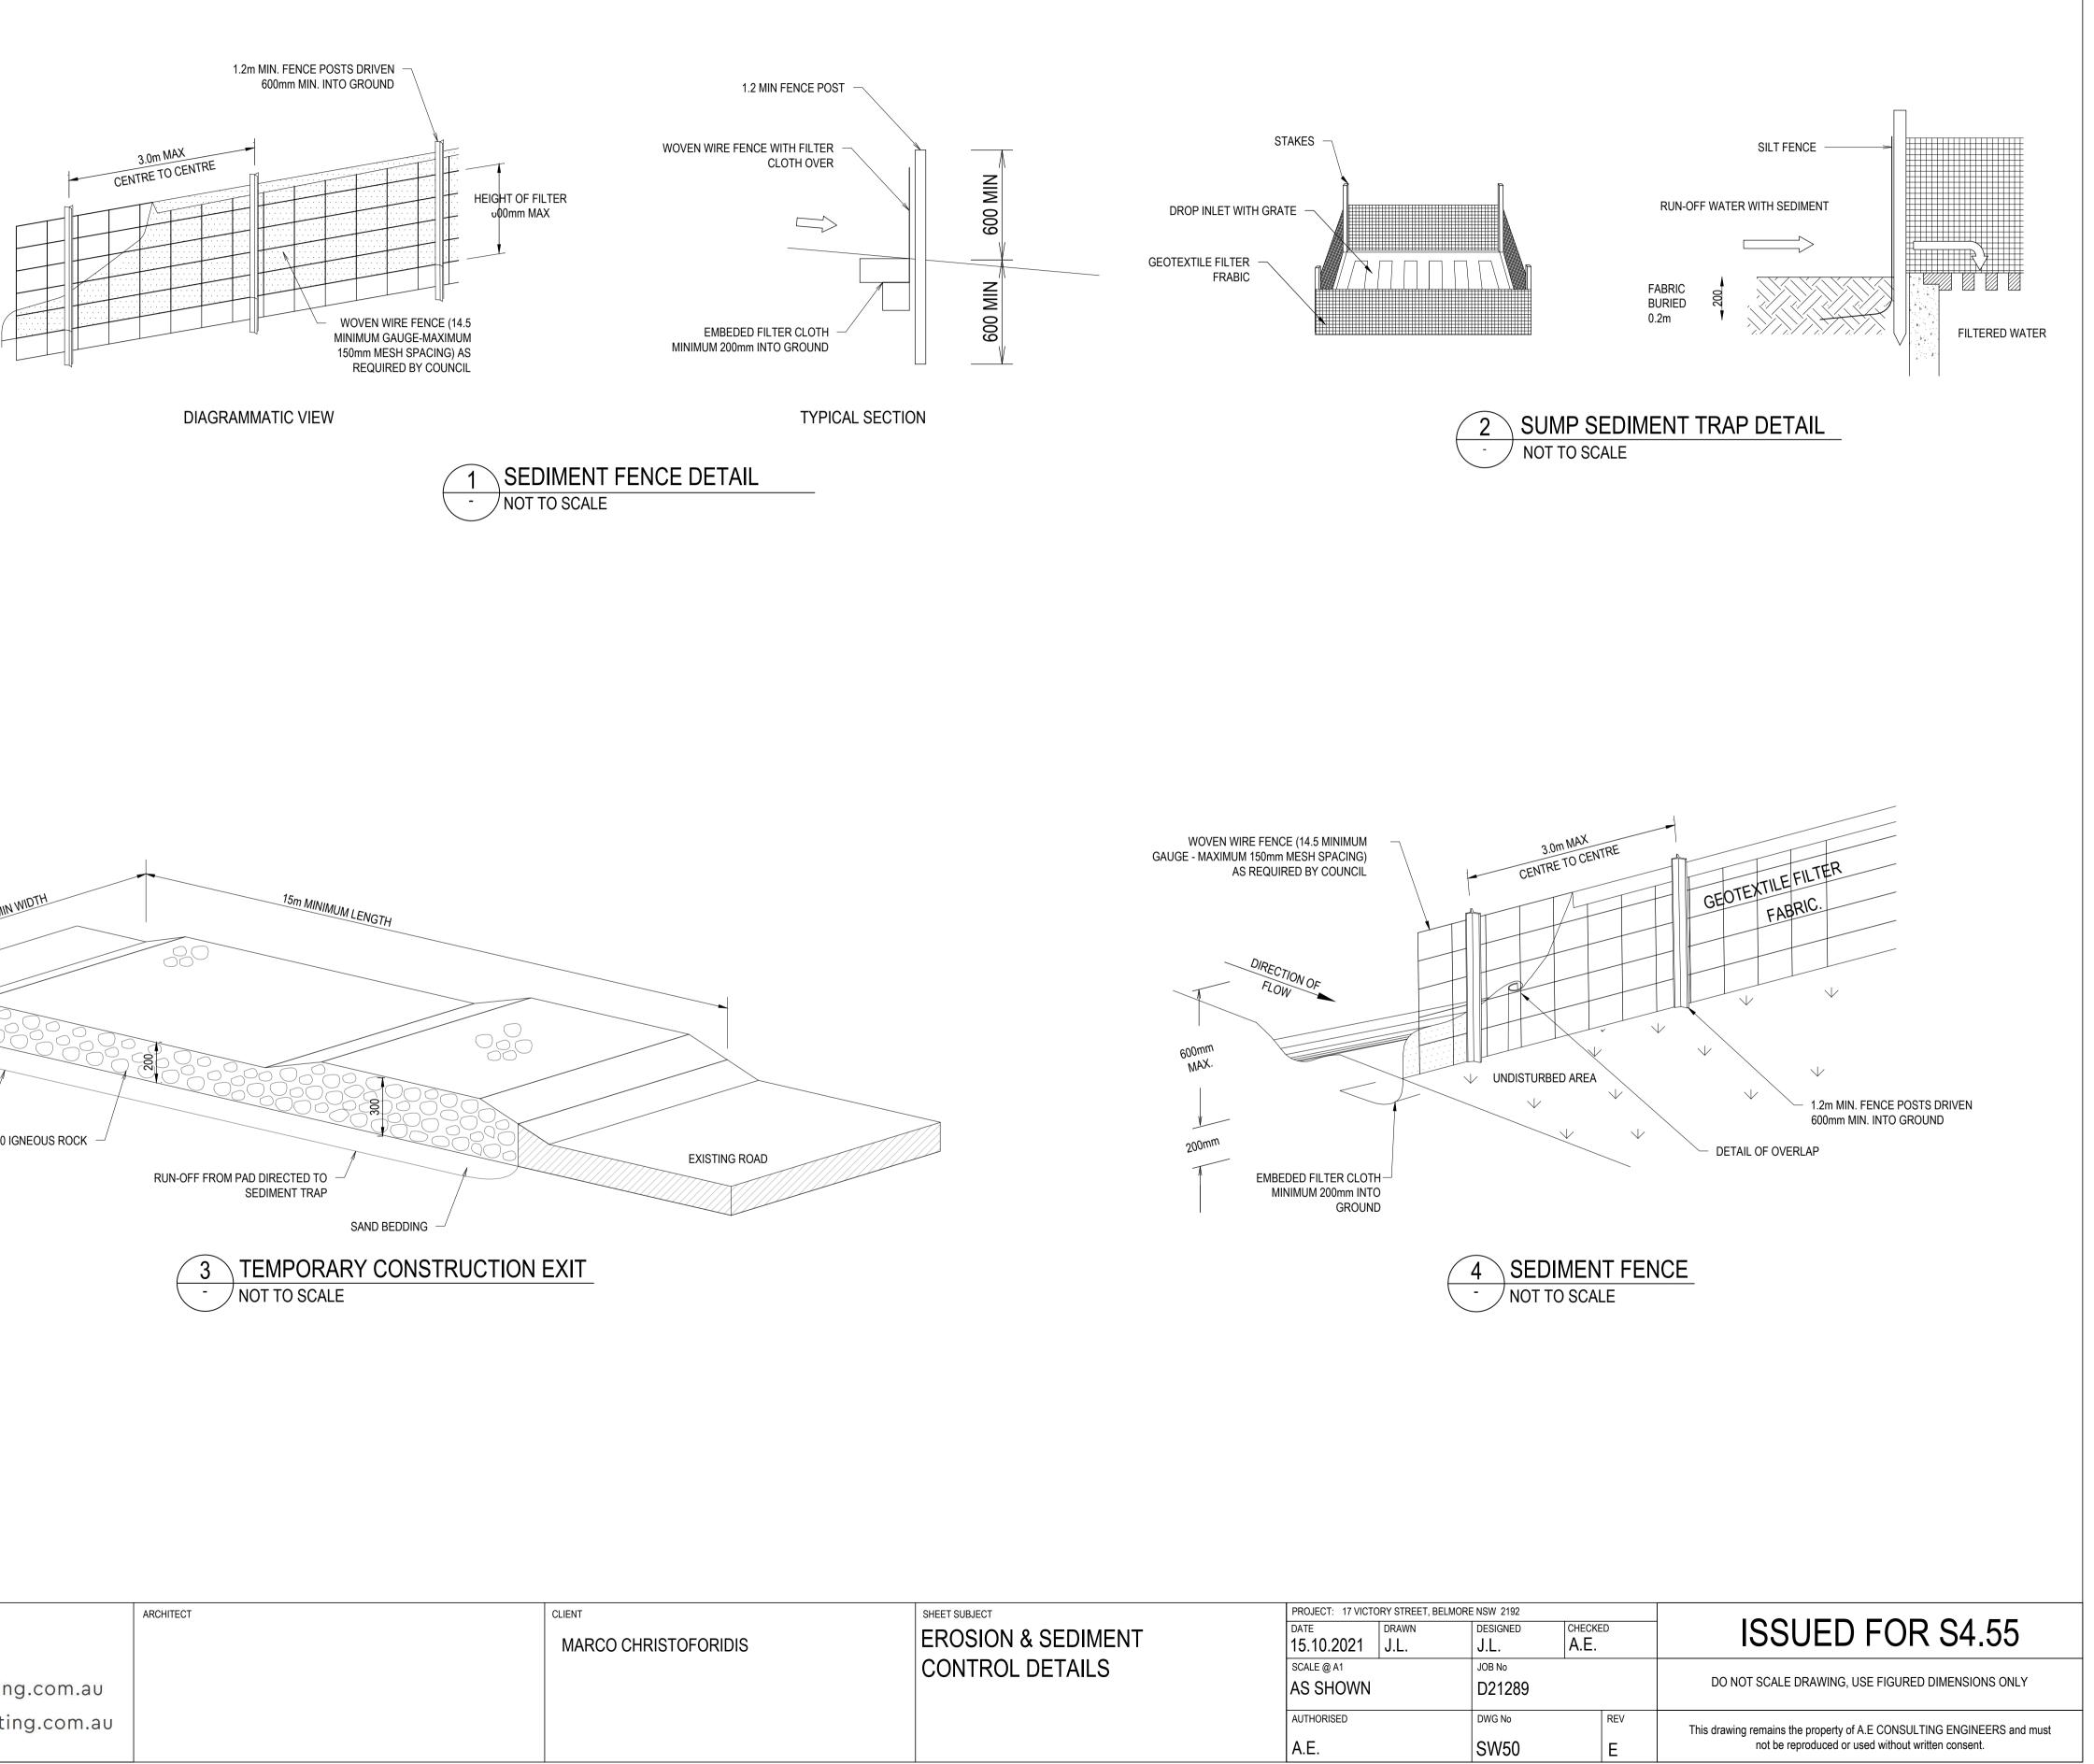


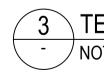

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E ISSUED FOR S4.55 D ISSUED FOR C.C. APPROVAL	A.E.	J.L. 26.11.24 J.L. 25.11.22		P: 9037 0731	ARCHITECT		MARCO CHRISTOFORIDIS	SHEET SUBJECT EROSION & SEDIMENT	DATE DRAWN 15.10.2021 J.L.
C ISSUED FOR C.C. APPROVAL B ISSUED FOR APPROVAL	A.E. A.E.	J.L. 08.09.22		E: info@aeconsulting.com.au				CONTROL DETAILS	SCALE @ A1 AS SHOWN
A ISSUED FOR APPROVAL	A.E.	J.L. 18.20.21	CONSULTING	W: www.aeconsulting.com.au					AUTHORISED
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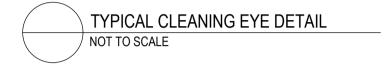



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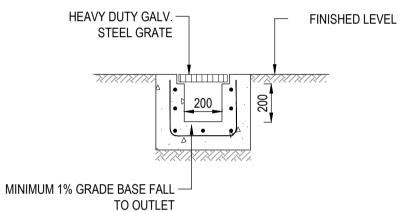
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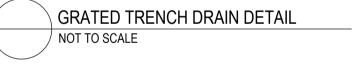
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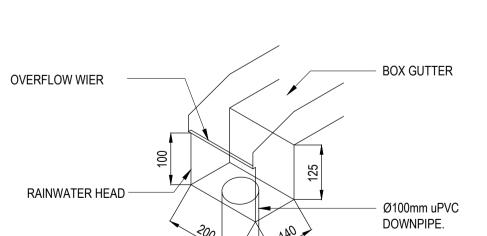


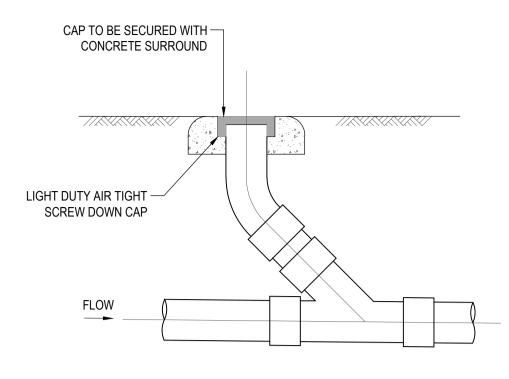


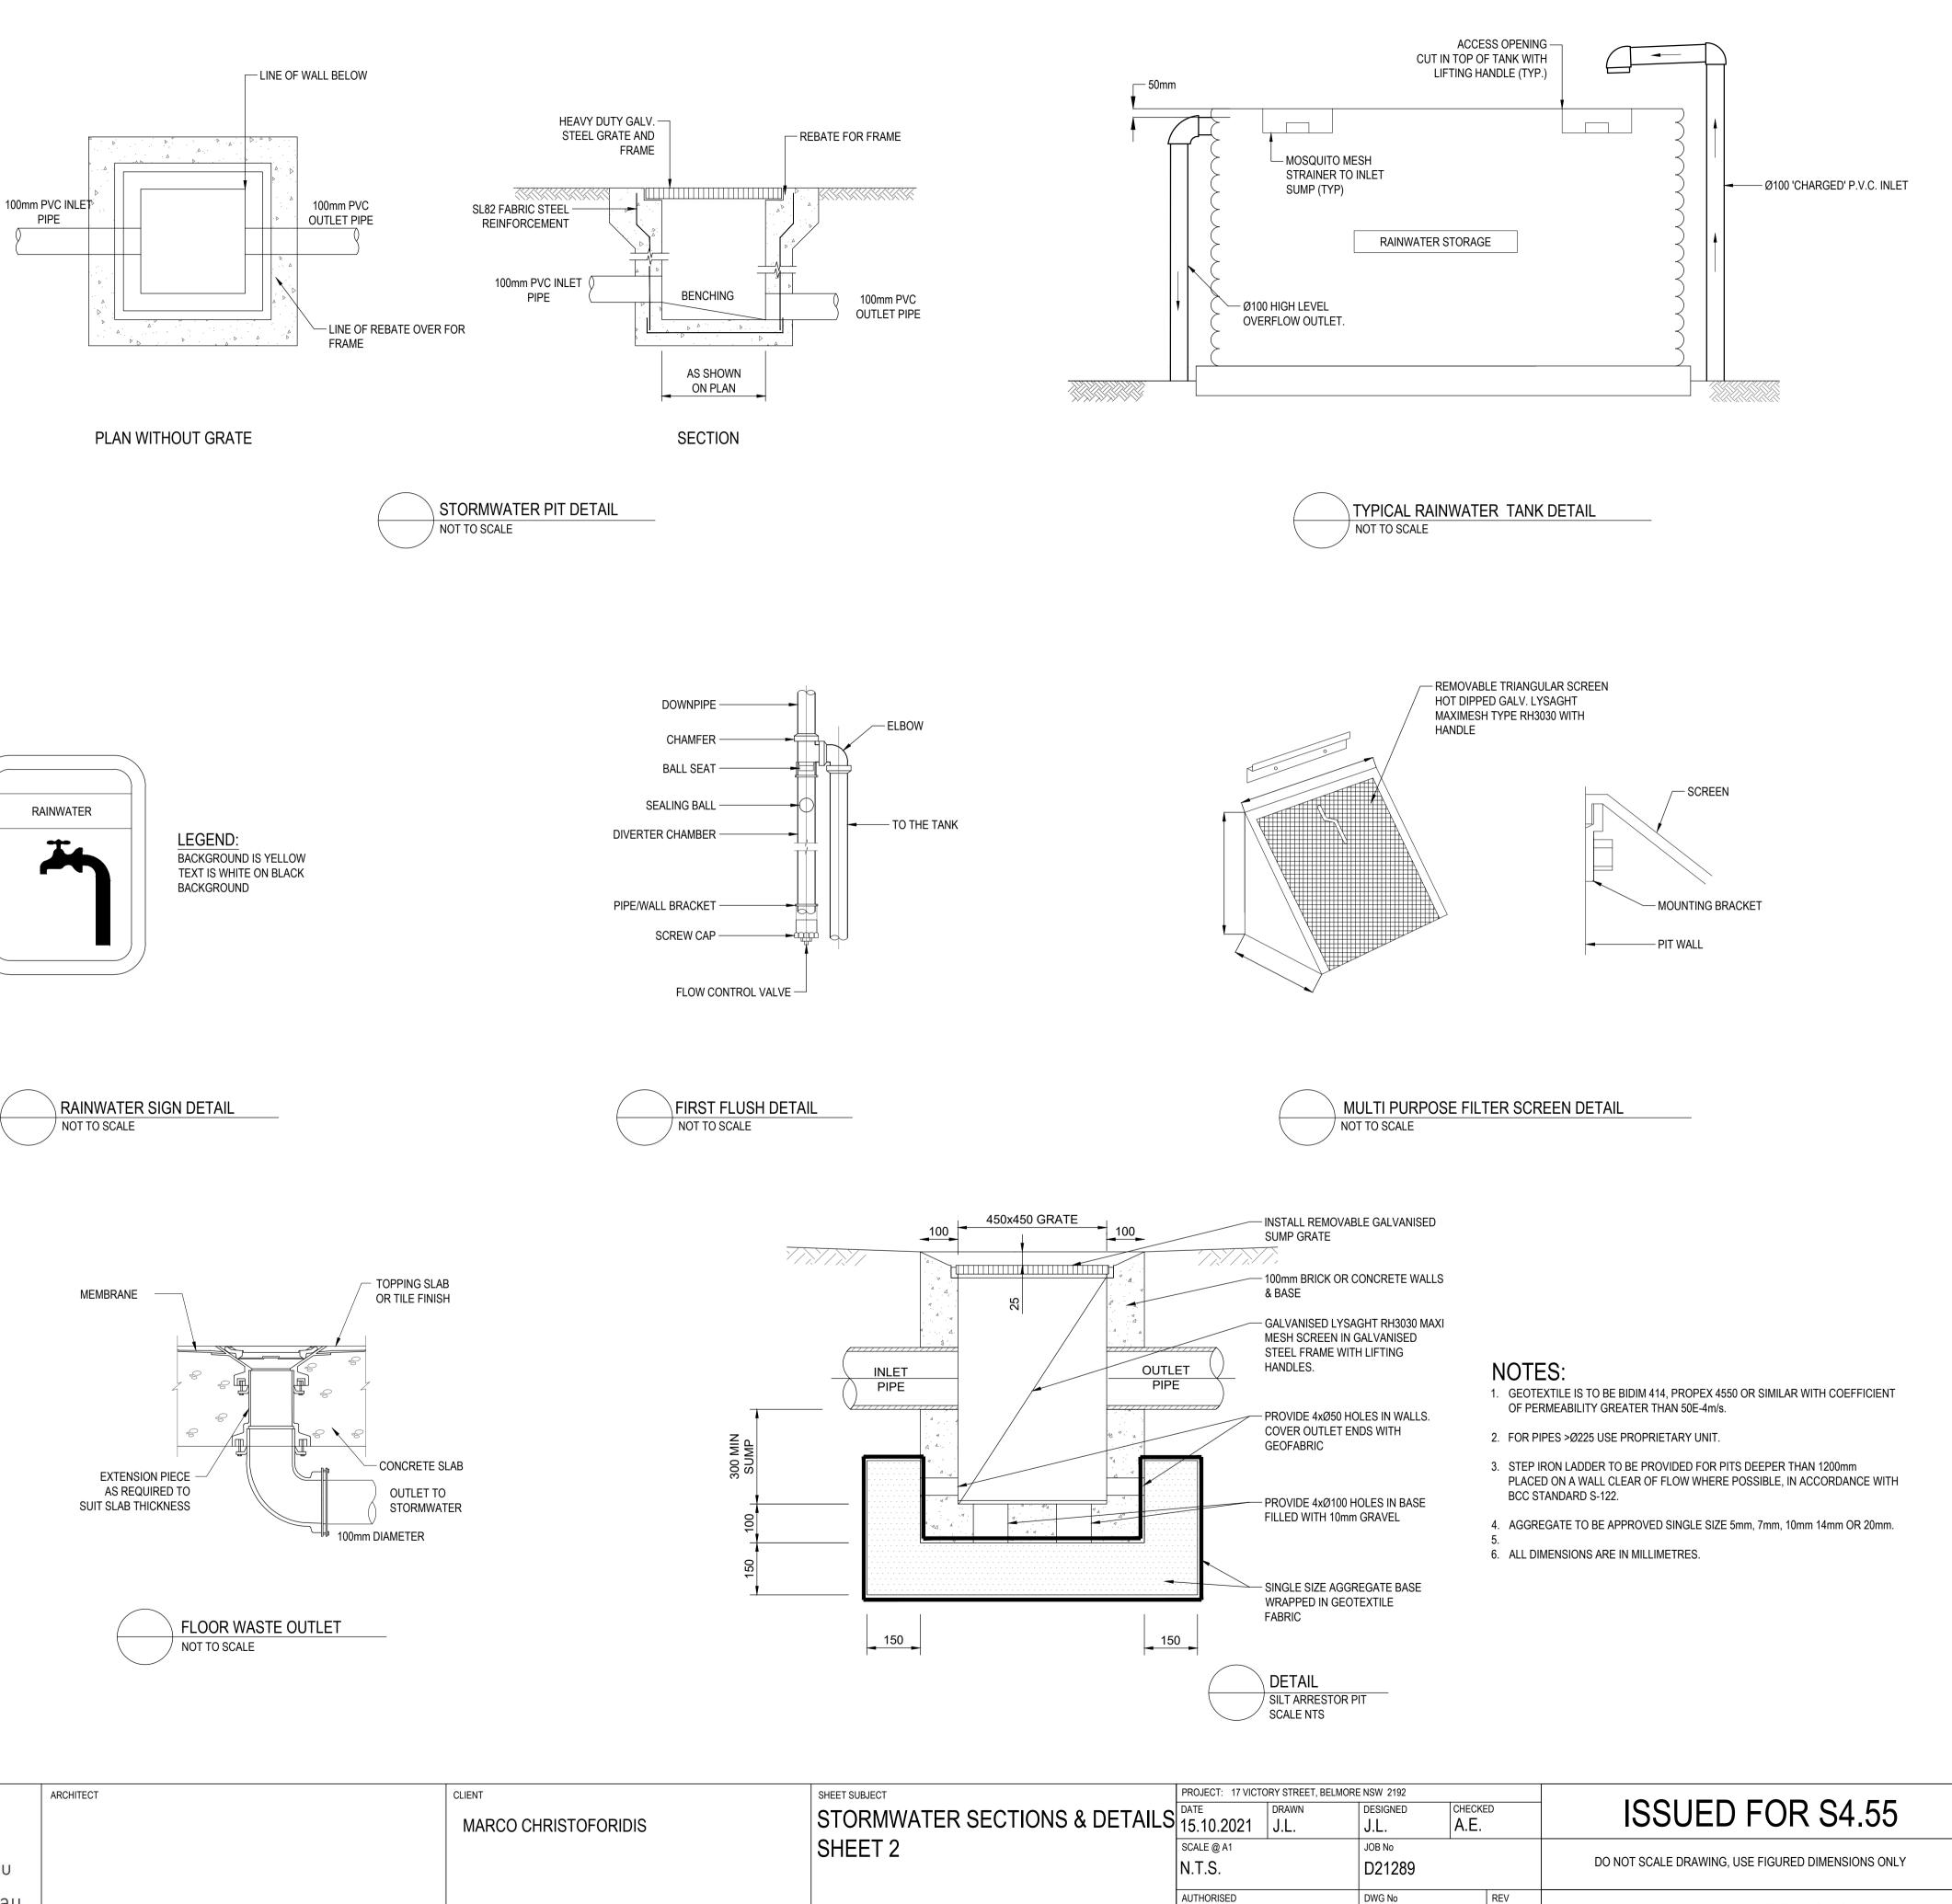






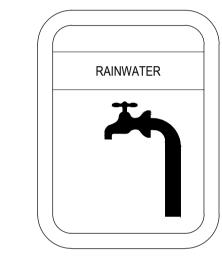

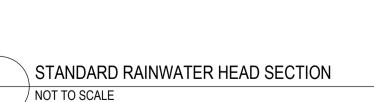

A1

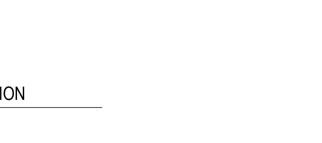

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	MARCO CHRISTOFORIDIS	STORMWATER SECTIONS & DETAILS	DATE 15.10.2021	dra J.L
		SHEET 2	SCALE @ A1	
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